GENERAL NOTES

GENERABUILDING PERMIT

<u>Dimensions</u>

All dimensions are to be checked by the builder/subcontractor on site and any disgrepancies brought to the attention of the drafts person prior to construction. When a dimension is not clear it is the builder's responsibility to clarify the dimension with the architect or drafts person. These drawings are not to be scaled. Peter I alor

BS-L 40110

Documentation

Read these drawings in conjunction with all architectural and other consultants' documents including the specification.

Building Setout

The building shall be setout by a licensed land surveyor. Do Not build over the title boundary or existing fence line. During the setout if a discrepancy is found crossovers as specified. in the dimensions or the land survey the builder shall contact the building designer and the land surveyor for clarification.

CONSULTANTS

Land Surveyors Documents

Refer to land surveyor's drawings and subdivision plans for all existing site details including the following, but not limited:

Title boundary

Title Dimensions

Distance to nearest street corner

Existing fence locations and heights

Existing site levels

Existing trees and other features such as adjoining buildings, out buildings,

The land surveyor's document's take precedence over the architectural documents for all survey work.

Structural Engineer's Documents

Refer to Engineer's documents for all structural requirements. The structural engineer's drawings take precedence over the architectural documents for all structural and protection work.

Geotechnical Report

Refer to the Geotechnical report for all geotechnical information. The geotechnical report takes precedence over the architectural documents for all geotechnical work

Civil Engineer's Documents

Refer to Engineer's documents for all civil requirements. The civil engineer's drawings take precedence over the architectural documents for all civil work.

Mechanical Engineer's & A/C Contractor's Documents

Refer to Engineer's & A/C Contractor's documents for all mechanical ventilation and air conditioning requirements. The Mechanical Engineer's and A/C Contractor's drawings take precedence over the architectural documents for all mechanical ventilation and air conditioning work

Energy Rating Reports

Refer to energy rater documents for all requirements. The energy rating reports take precedence over the architectural documents for all work.

SITE PREPARATION

Protection Works

Carry out all protection works in accordance with engineer's documents and recommendations (refer specification).

The builder shall be responsible for the protection of the adjoining properties and construction works. And shall replace any damaged work without cost to the proprietor. The builder shall maintain the site in a clean condition by removing waste materials at regular intervals. Ensure that no waste material is dumped on adjoining properties.

Demolition and Site Clearing

Do not proceed with demolition and site clearing work until all demolition and tree removal permits have been obtained. Carry out all works in accordance with permits. Remove all building materials, including in-ground building services. At completion of works the site shall be clean and safe. Do not leave any building material on site. All fill required shall be clean fill to comply with engineer's documents.

Trees and vegetation

Remove trees and vegetation only as noted on permit to be removed have been approved. Gr

Refer planning drawings and conditions for stre

Excavation

Excavate as required for the construction work documents. Comply with the recommendations

Shoring

The builder shall allow providing shoring to the environment and to retain the sides of all excav engineer's documents and geotechnical report

Crossover

Construct the new crossover to the satisfaction

Street Footpath and Roadway

Make good neighboring footpaths, kerbs, channels and construct the new footpath, kerbs, channels and roadway to the satisfaction of the responsible authority.

Nature Strip

Make good and prepare the new nature strip to the satisfaction of the responsible authority.

Termite Control General

Provide termite barriers that comply with AS 3660.1. and provide a certificate/ guarantee to prove that the work has been carried out.

Termite Control: Timber

Provide termite barriers that comply with as 3660.1. and provide a certificate/guarantee to prove that the work has been carried out.

Termite control Timber: Only use termite resistant timbers to touch the ground as per Australian standard

Non-Resistant Timbers: Preferably use timbers that are slightly termite resistant as per Australian standards. Where non-resistant timbers are used, they should be away from the ground with a min, inspection zone area, Refer to Australian standards.

Ant Caps: Ant caps can be used with timber stumps.

Subfloor structure: All piers and subfloor masonry to be fully strip shielded to As 3660.1. Where subfloor clearance does not allow for inspection (see as 3660.1) Provide full under floor granitgard barriers.

Termite Control: Concrete

Where required, termite treatment to comply with BCA Part 3.1.4 not 3.1.3 and in accordance with AS 3660.1. and provide a certificate/guarantee to prove that the work has been carried out.

Granitgard with Slab

Penetrations: Ensure that all penetrations are protected to manufacturers/installers recommendation and guarantee.

Perimeter Treatment: Provide perimeter barriers to manufacturers/installers recommendation and guarantee. Check that any areas of contact with non-termite proof materials are separated by a min. inspection zone as per Australian standards where any clashes, notify architect

Control/Pour Joints: Ensure that all pour joins are treated to manufacturers/installers recommendation and guarantee. Note that control/pour joints should be clean.

Quality & Strength of concrete: Slabs to meet as 2870 & as 3600 and be vibrated where appropriate. Where sub floor clearance does not allow for inspection (see as 3660.1) provide full under floor granitgard barriers.

SERVICES

Services

Supply and install all services as required to the satisfaction of the responsible authorities, refer to all construction works documents for services required. Confirm supply pipe sizes required prior to installation.

Supply and install gas, electrical and water meters, as required to the satisfaction of the relative responsible authorities.

Location indicated on the architectural plans is indicative only/refer to service engineer's drawings

Gas and water meter to be mounted behind front fence facing the street

OQQ16JQQES 4 Aug 2021

Assessor Kaial Anand Accreditation No. DMN/18/1882 **Address**

17 Dewhurst Circuit Cranbourne East VIC 3977

HOUSE

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the box so it is flush with the face of

ed detail and to suit A4 size tect/refer drawings and specification.

icity supply in the street. Provide all be to satisfaction of the responsible

I to meet demand.

the front fence to each house to allow bling. Supply and install wiring to all

Barbecue: Gas Supply – T.B.C.

points marked throughout each house.

Provide direct connection to the natural gas supply as shown on plan. Conceal all pipe work and locate the connection point the required distance by regulation from connection point the required distance by regulation from the nearest window (confirm location of point with architect and client)

<u>Sewer</u>

Connect property to existing sewer point if it is in an appropriate position. If not, make new connection. Refer service engineer's drawings.

Connect property to existing water mains. Refer service engineer's drawings.

国際機械国

Gas Supply

Refer service engineer's drawings.

DOMESTIC NOTES

The site shall be adequately fenced off during construction to prevent public

- No part of the building shall project beyond the boundary line, i.e.; including
- The premises shall be treated for termite protection using a chemical barrier in accordance with AS 3660.1-2014. Alternatively physical barriers may be adopted, such as ant caps or grantigard. If adopting ant caps ensure there is sub floor clearance of 400
- Eaves with 900mm (but no closer than 450mm) of the boundary shall be constructed using non combustible materials.
- Eaves exposed to within 450 of the boundary shall be protected by either a
- Rainwater heads, fascias, gutters, downpipes and the like within 450mm of the boundary shall be constructed of non combustible materials
- Flues, chimneys, pipes, domestic fuel tanks, cooling or heating appliances or other services must not be built within 450mm of the boundary
- Openings in external walls within 900mm from the side facing the boundary require to be protected, i.e.; windows shall be fixed, fire rated windows no less than -/60/-:
- Open able windows within 1 metre of the finished floor level shall be restricted so that the openings do not permit a 125mm sphere to pass through it, if the fall is greater than 1 metre from the natural ground level.
- The door to a fully enclosed sanitary compartment shall open outwards, side or be readily removable from the outside of the compartment, i.e; removable hinges.
- The stumps are required to be brace in accordance with as 1684-1992, if the height of the stump from natural ground level to the underside of the bearer excess the ratio of 15 times the width of the stump, i.e; a 1 100 X 100 stump has a maximum height

- Vertical articulation joints shall be provided in straight, continuous walls (having no opening)at no more than 6m centers and located no closer than the height of the wall away from corners. Where openings more than 900 x 900 mm occur, then articulation joints are to be reduced to 5 m centers and positioned in line with at least one edge of the opening. Furthermore, articulation joints should be provided at or near changes in foundation soil, at deep rebates for service pipes, where walls change in thickness and between new and old brickwork. Vertical articulation joints shall be provided in straight, continuous walls (having no opening)at no more than 6m centers and located no closer than the height of the wall away from corners. Where openings more than 900 x 900 mm occur, then articulation joints are to be reduced to 5 m centers and positioned in line with at least one edge of the opening. Furthermore, articulation joints should be provided at or near changes in foundation soil, at deep rebates for service pipes, where walls change in thickness and between new and old brickwork.
- Sub floor ventilation shall be provided at a rate of 7300 mm2/m, where the minimum sub floor clearance is 150 mm.
- Smoke detectors shall be a BRK 86 RAI 240V self contained smoke alarm or the equivalent to be connected to the consumer power mains in accordance with as 3786. where more than one smoke detectors, the detectors are to be interconnected.
- The wall surface of a shower enclosure shall be impervious to water to a height of 1.8m above the floor and immediately adjacent or behind a bath, basin or sink to a height not less than 150mm above the fixture.
- All glazing shall be in accordance with AS 1288-2006 wherein, glazing within 500mm of the floor level shall be 5mm thickened annealed, glazed doors and associated side panels shall be 5.38mm laminated safety glass and bathroom windows within 1.5 m of the bath or 500 mm from the shower enclosure shall be 3mm toughened safety glass.
- Stairs (other than spirals) shall be constructed in accordance with the following:

Risers (R) - Max. 190 mm and min. 115mm

Going (G) - max. 355mm and min. 240mm

Where 2R+G- Max. 700mm and min. 550mm. A landing not less than 750mm wide shall be provided where the sill of

- a threshold of a doorway opens on to a stair that provides a change in floor level or floor to ground level greater than 3 risers or 570mm. The height of a balustrade shall be no less than 1000mm above the
- floor level, balcony or landing and 865mm above the nosing of the stair tread. The spacing of balustrades either vertically or horizontally shall not be more than 125mm.
- The chimney or fuel shall extend 300mm above any part of the 20. building within a horizontal distance of 3.6m.
- The earth shall extend 300 mm beyond the front of the fireplace and 150mm beyond each side of the opening. If the flooring is combustible the hearth must be situated 150mm above the floor.
- Where an energy efficiency report was required, the thermal insulation installed must comply with the report.
- For new dwellings constructed to achieve 6-stars, a solar hot water system or reticulated rain water tank for toilet flushing must be installed in accordance with practice note 55 issued by the building commission.
- Laundries, bathrooms, ensuites and powder rooms that are not naturally ventilated, shall be provided with mechanical ventilation.
- The storm water discharge shall be connected to the existing legal point of discharge
- The ground beneath the suspended floor must be graded so that the area beneath the building is above the adjacent external finished ground level and surface water is prevented from ponding under the building. Alternatively, agricultural pipes shall be provided beneath the building to drain ponding surface water. Surface water must be diverted away from a slab-on-ground, so that the adjacent external finished surface surrounding the slab must be drained to move surface water away from the building and graded to give a slope of not less than 50mm over the first 1m from the buildings.
- All buildings constructed must not occupy more than 60% of an allotment and not more than 80% of the allotment can be covered by impermeable surfaces.
- Safety pool fencing shall be in accordance with AS 1926.1 wherein a suitable barrier shall be provided at a minimum height of 1.2m and vertical balustrades are spaced at no greater than 100mm. The gate shall be hung so that it swings away from the pool area and also be at a minimum height of 1.2m, self closing and the self-latching or self-locking device shall be located at least 1.5m. above the floor level. The perimeter paling fencing shall be treated so that the rails are beveled on a 60 degree angle to prevent children from climbing over the fence. Furthermore, ensure all perimeter pool fencing has a 1200 mm clear span from climbable objects, i.e.; a retaining wall.



NOTE: PLANS ARE NOT TO BE SCALED





01-08-2021 Date

PROJECT:

CLIENT:

Single Storey House @ Lot 232 17 DEWHURST CIRCUIT, CRANBOURNE EAST

Drawing Title: **GENERAL NOTES**

PRFI IMINARY


NORTH


DEC 2020 Author Checked:


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Project No. 5072 Drawing No. A000 Revision:

Scale: 1:100 @A3



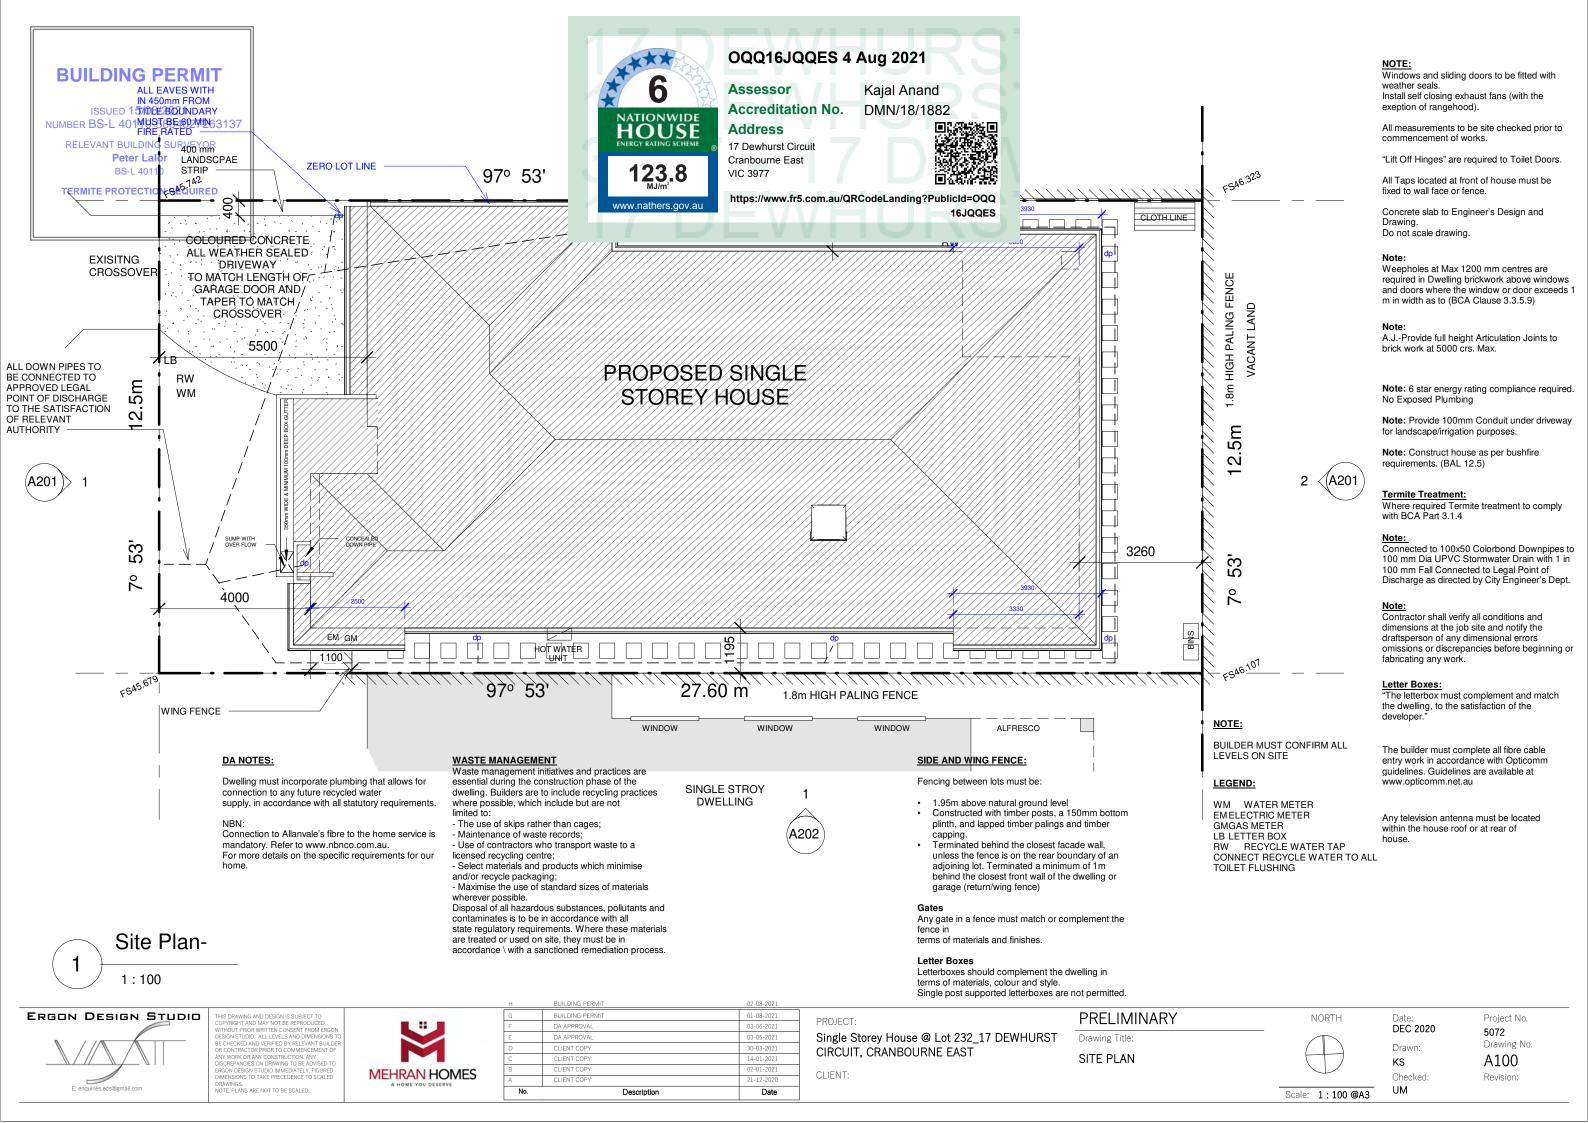

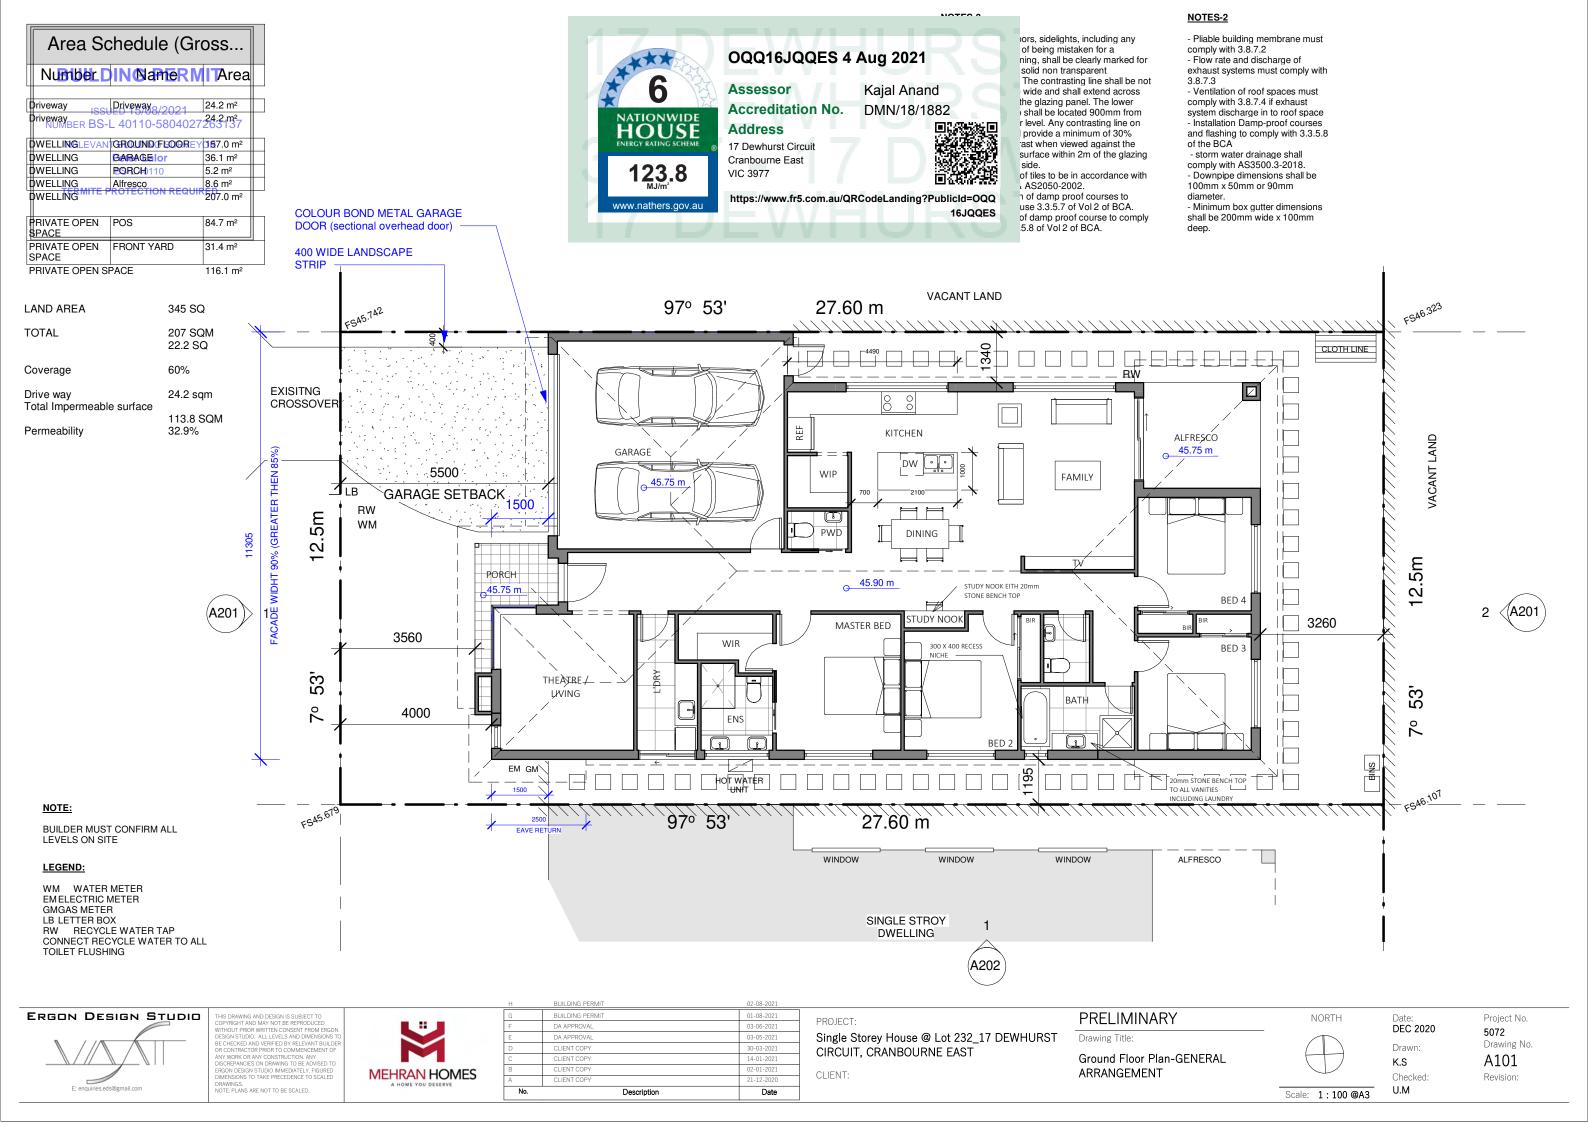

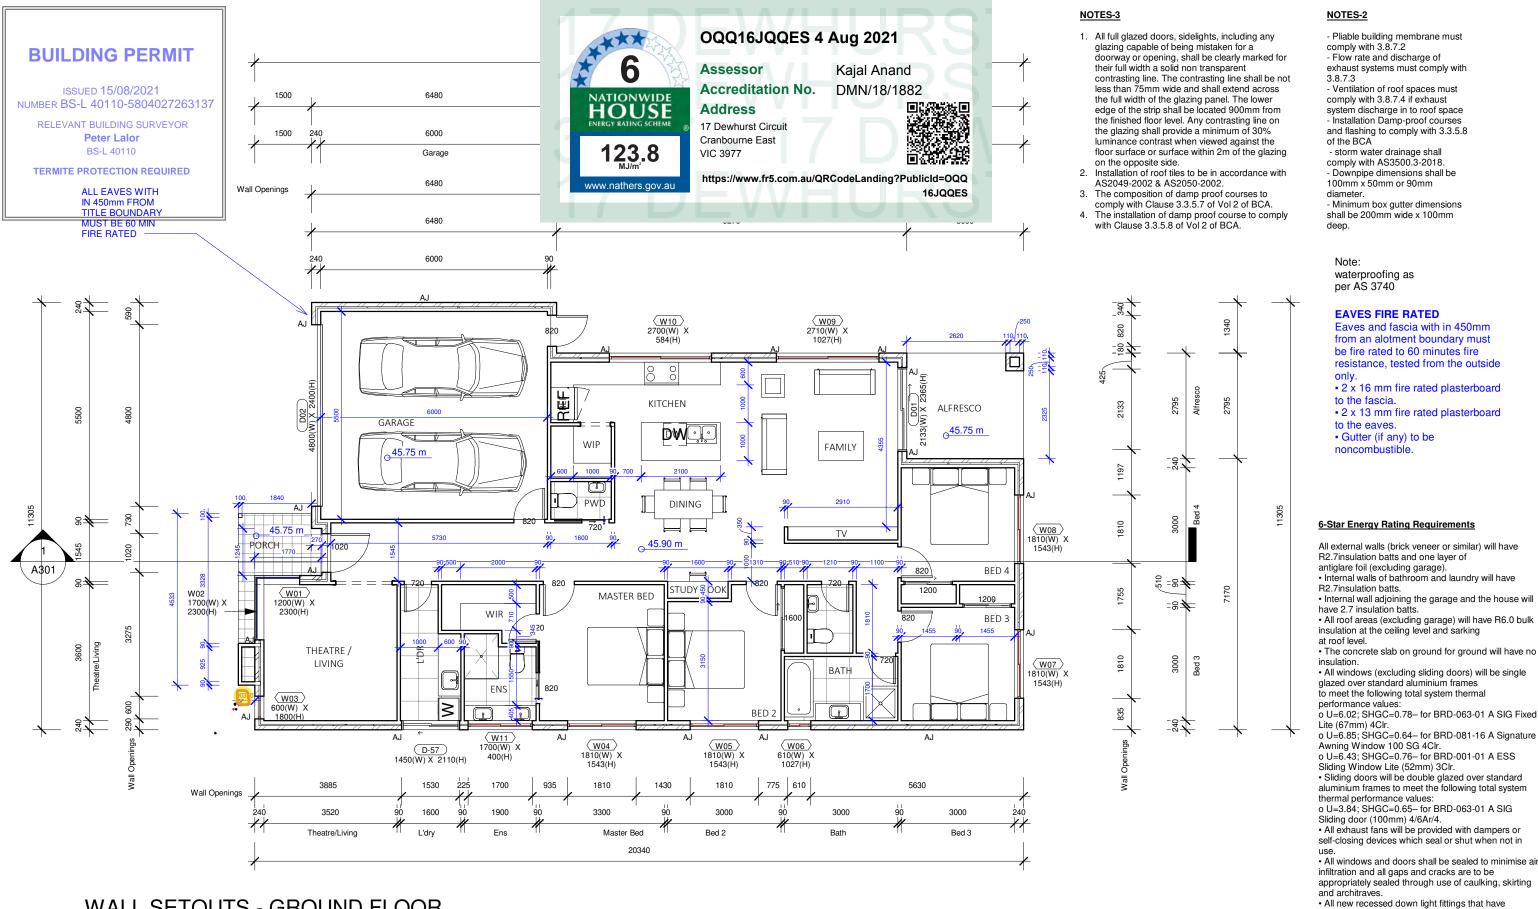WALL SETOUTS - GROUND FLOOR PLAN -

IS DRAWING AND DESIGN IS SUBJECT T PYRIGHT AND MAY NOT BE REPRODUC

)rawings. Note: Plans are not to be scaled.

1:100

ERGON DESIGN STUDIO

MEHRAN HOMES

01-08-2021 BUILDING PERMIT Description Date

PROJECT:

Single Storey House @ Lot 232_17 DEWHURST CIRCUIT, CRANBOURNE EAST

CLIENT:

Drawing Title:

WALL SET OUT PLAN GF



Scale: 1:100 @A3

DEC 2020 Drawn

and top of the down light.

an approved unventilated cover that

- Ventilation of roof spaces must

- storm water drainage shall

Note:

waterproofing as per AS 3740

to the fascia.

to the eaves.

noncombustible

• Gutter (if any) to be

EAVES FIRE RATED

Eaves and fascia with in 450mm

from an alotment boundary must be fire rated to 60 minutes fire resistance, tested from the outside • 2 x 16 mm fire rated plasterboard

• 2 x 13 mm fire rated plasterboard

Project No. 5072 Drawing No.

A102 Revision:

Author Checked: Checker

openings allowing air to pass through to a ceiling cavity (e.g. Adjustable down lights) fitted with

allows for ceiling insulation to closely enclose the sides

PRELIMINARY

NOTES:

 DOWN-PIPES SERVING THE PROPOSED DWELLINGS & GARAGES MUST BE BLOATED VIT NOT GREATER THAN 12m OF EACH OTHER 15/08/2021

SMOKE ACARM 110-5804027263137

SELF CONTAINED SMOKE ALARM 240 VOLT MAINS CONNECTED WITH BATTERY • BACK UP COMPLYING WITH AS 3786 BS5446, UL217 TERMITE PROTECTION REQUIRED

GENERAL NOTES

- PROVIDE POWER POINT FOR UNDER **BENCH OVEN**
- PROVIDE POWER POINT FOR COOK TOP
- PROVIDE POWER POINT FOR HEATING UNIT AND HOT WATER UNIT
- PROVIDE POWER POINT FOR **DISHWASHER**
- PROVIDE POWER POINT FOR REFRIGERATOR
- PROVIDE POWER POINT FOR RANGE HOOD



OQQ16JQQES 4 Aug 2021


Accreditation No. **Address**

17 Dewhurst Circuit Cranbourne East

DMN/18/1882

Kajal Anand

https://www.fr5.com.au/QRCodeLanding?PublicId=OQQ 16JQQES

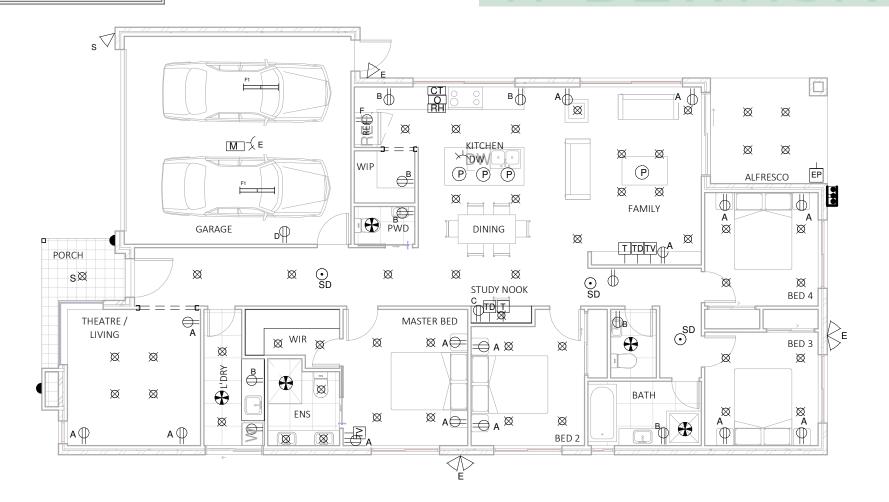

LIGHTING LAYOUT - GF

1:100

Area Schedule (Gross		
Number	Name	Area

Driveway	Driveway	24.2 m ²
Driveway		24.2 m ²

DWELLING	GROUND FLOOR	157.0 m ²
DWELLING	GARAGE	36.1 m ²
DWELLING	PORCH	5.2 m ²
DWELLING	Alfresco	8.6 m ²
DWELLING		207.0 m ²

PRIVATE OPEN SPACE	POS	84.7 m ²
PRIVATE OPEN SPACE	FRONT YARD	31.4 m²
PRIVATE OPEN S	PACE	116.1 m ²

BUILDING PERMIT 01-08-2021 Description Date

CIRCUIT, CRANBOURNE EAST

CLIENT:

ELECTRICAL LEGEND

TV

↑ YAORA GPO_A DENOTES 300mm AFFL **B** DENOTES 100mm ABOVE BENCH TOP C DENOTES 100mm BELOW BENCH TOP D DENOTES 1200mm AFFL **E** DENOTES CEILING MOUNTED E DENOTES 1500mm AFFL WHERE " — " DENOTE DOUBLE GPO

[CT] GPO COOKTOP (HARDWIRED)

O GPO OVEN (HARDWIRED)

RH GPO_RANGE HOOD (HARDWIRED)

DW GPO_DISHWASHER (HARDWIRED)

TD D DATA/COMMUNICATIONS POINT

TV POINT (INCLUDING FREE TO AIR & PAY TV) F DENOTES 1500mm AFFL

T PHONE POINT

« SELECTED SWITCH <u>D</u> DENOTES DIMMER SWITCH

≪ SELECTED TWO WAY SWITCH

MAIN SWITCHBOARD (UPGRADE AS REQUIRED)

oxtimes 0 7 WATT LOW VOLTAGE RECESSED DOWN LIGHT **D** DENOTES DIRECTIONAL FITTING **S** DENOTES SENSOR LIGHT FITTING

O OYSTER LIGHT

(P) 15 WATT LOW VOLTAGE PENDANT FITTING

W 50 WATT WALL MOUNTED (U/S OF FITTING 2.1 AFFL)

 WALL MOUNTED EXTERIOR LIGHT E FITTING (U/S OF FITTING 2.4 AFFL) "S" STANDS FOR SENSOŔ LIGHT

○ WALL MOUNTED (FLURO FITTING @ 2.1 AFFL)

MECHANICAL EXTRACTION/EXHAUST FAN

WALL SCONCES

2x18W FLUORESCENT LUMINARE

LOW VOLTAGE LIGHTS (300mm OFF STEP)

• SMOKE ALARM CONNECTED TO WITH BATTERY BACK UP

M MOTOR FOR TILT UP DOOR

⋈HWU HOT WATER UNIT

INT INTERCOM

SC SECURITY PAD

GP **GAS POINT**

990 **EXTERNAL WATER TAP**

 \oplus 40 WATT SURFACE MOUNTED BATTEN LIGHT

or AIR CON. DISTRIBUTION GRILL

EXTERNAL POWER POINT

AIR CON CONTROLLER

AIR CONDITION UNIT

AC SW or O SEWER STACK

VC VACUUM

E-PIT ELECTRICAL PIT

⊖S2 SENSOR LIGHT DOUBLE FITTING

NOTE:

ALL GPOS ARE LOCATED IN **JOINERY**

NEW LIGHTING MUST NOT EXCEED 5W/m² FOR INTERNAL, 4W/m² FOR ANY LIGHTING ON A VERANDAH OR BALCONY ATTACHED TO THE DWELLING AND 3W/m² FOR ANY GARAGE, CARPORT OR SHED IN ACCORDANCE WITH BCA Vol.2 Part 12.5.5.5.

ERGON DESIGN STUDIO

IRAWINGS. IOTE: PLANS ARE NOT TO BE SCALED.

MEHRAN HOMES

Single Storey House @ Lot 232_17 DEWHURST

PRELIMINARY

Drawing Title:

LIGHTING LAYOUT PLAN



Scale: 1:100 @A3

DEC 2020 KU

5072 Drawing No. A103

Project No.

Checked: 1:100


Revision:

BUILDING PERMIT ISSUED 15/08/2021 NUMBER BS-L 40110-5804027263137 RELEVANT BUILDING SURVEYOR **Peter Lalor** BS-L 40110 TERMITE PROTECTION REQUIRED

OQQ16JQQES 4 Aug 2021 Assessor Kajal Anand **Accreditation No.** DMN/18/1882 HOUSE **Address** 17 Dewhurst Circuit Cranbourne East VIC 3977 https://www.fr5.com.au/QRCodeLanding?PublicId=OQQ RF1 16JQQES Ceiling Level 48600 Ground Floor Level 45900 DOOR OPENING 38.4% OF THE FRONTAGE

FRONT FACE FINISH CALCULATION Elevation D

TOTAL FACADE ARE EXCLUDIN WINDOW AND DOOR OPENINGS 15.92m² FACE BRICK AREA 6.7m² 42% (LESS THEN

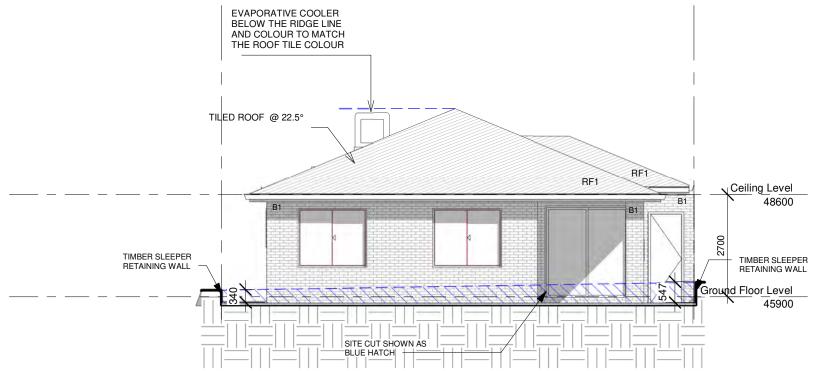

Elevation A

1:100

1:100

Note:

All glazing to comply with AS 1288-2006.

Safety glass shall be fitted to

- 1. All glass doors
- 2. Side lites within 300mm of doors.
- 3. Windows within 500mm of floor level.

Note:

Face Brickwork to be tied to Stud Frame. Floor Vents at 7300 mm2/meter. Brickwork to comply with general compliance-

AS 3700 Requirements.

Note:

All external equipment and fixers to be screened from public view.

- NO SLIIDNG WINDOWS TO THE FRONT FACADE
 NO INFILL OR RECESSED PANELS ABOVE
 DOORS, WINDOWS OR GARAGE DOORS
 FINISH ABOVE THE OPENING MUST MATCH THE
- FINISH ON EITHER SIDE OF THE OPENING
- ROOF MATERIALS AND RAINWATER FIXTURES, INCLUDING GUTTERS, FLASHING, FASCIAS AND CLADDING, MUST BE MATTE FINISH AND NON-REFLECTIVE.
- EXTERNAL GLAZING THAT IS VISIBLE FROM THE PUBLIC REALM MUST NOT CONTAIN LEADLIGHT, STAINED CLASS. REFLECTIVE GLASS OR PATTERNED FILM.
- ROLL DOWN SECURITY SHUTTERS MUST NOT BE VISIBLE FROM THE PUBLIC REALM.
- GARAGE DOOR OPENINGS DO NOT OCCUPY MORE THAN 40% OF THE WIDTH OF THE PRIMARY FRONTAGE, UNLESS THE BUILDING IS TWO OR MORE STOREYS
 DRIVEWAYS MUST TAPER TO THE WIDTH OF THE CROSSOVER AT THE BOUNDARY.

Note:
All glazing to comply with AS 1288-2006.

Safety glass shall be fitted to

- All glass doors
 Side lites within 300mm of doors.
- 3. Windows within 500mm of floor level.



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I	А	CLIENT COPY	21-12-2020
ı	В	CLIENT COPY	02-01-2021
ı	С	CLIENT COPY	14-01-2021
ı	D	CLIENT COPY	30-03-2021
ı	E	DA APPROVAL	03-05-2021
Ī	F	DA APPROVAL	03-06-2021
ĺ	G	BUILDING PERMIT	01-08-2021
	Н	BUILDING PERMIT	02-08-2021

PROJECT:

Single Storey House @ Lot 232_17 DEWHURST CIRCUIT, CRANBOURNE EAST

CLIENT:

PRELIMINARY	
Drawing Title:	
ELEVATIONS-1	




DEC 2020 Drawn:

Author

5072 Drawing No. A201 Revision:

Scale: 1:100 @A3

Checked: KU

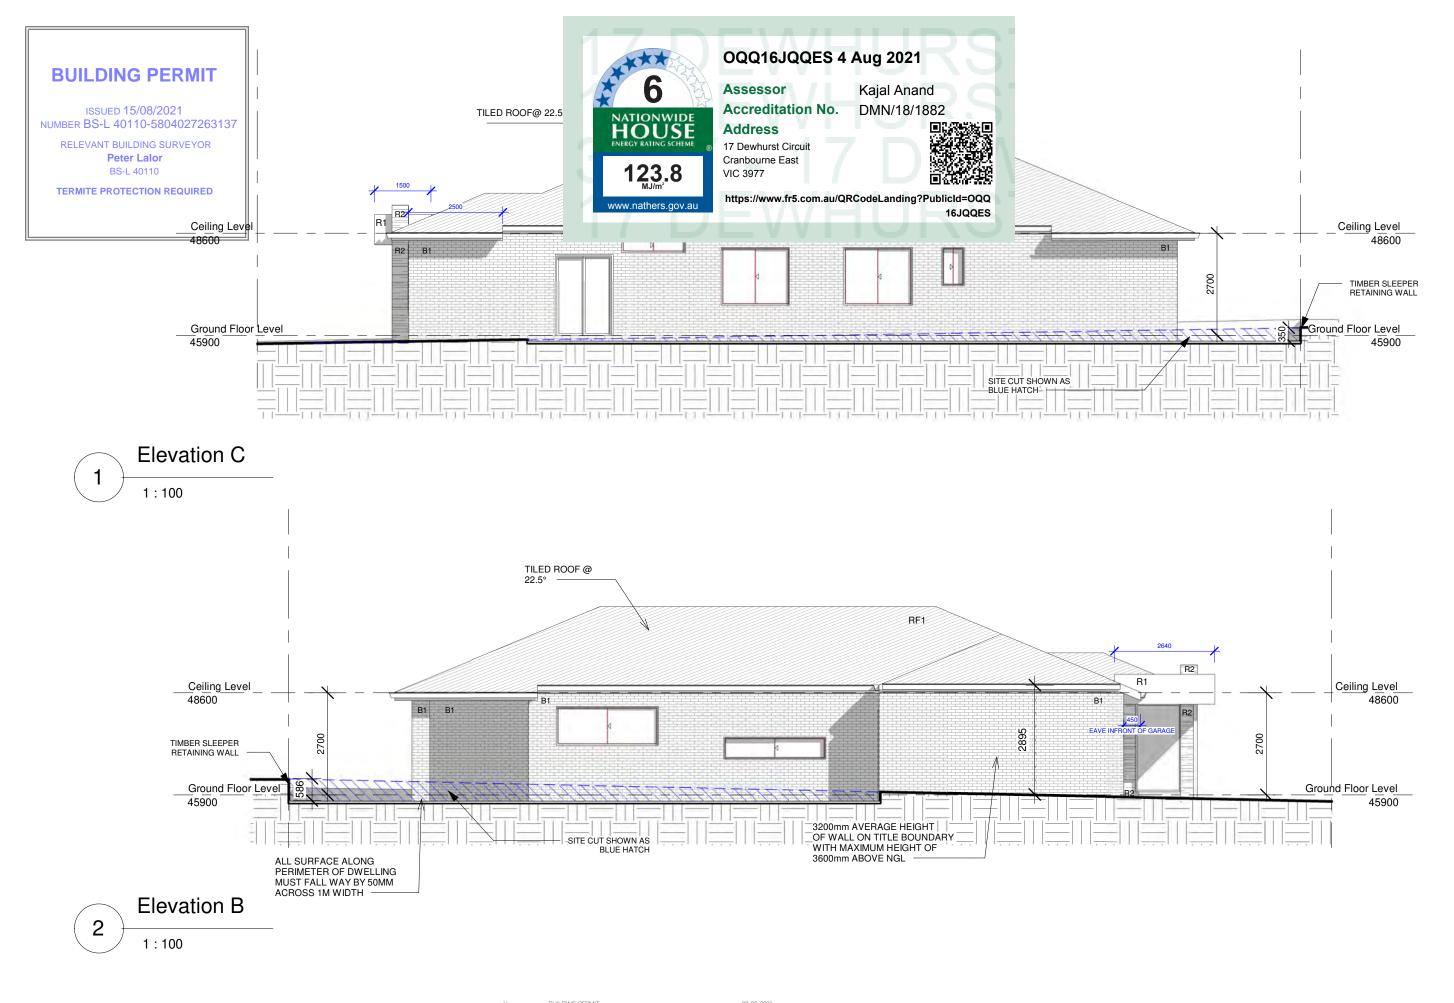



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NOTE: PLANS ARE NOT TO BE SCALED.



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G	BUILDING PERMIT	01-08-2021
Н	BUILDING PERMIT	02-08-2021

PROJECT:
Single Storey House @ Lot 232_17 DEWHURST
CIRCUIT, CRANBOURNE EAST

CLIENT:

AST ELEVATIONS-2

PRELIMINARY

Drawing Title:

	1	IORTH
_	(
	Scale:	1:100 @A3

Date: DEC 2020 Drawn: UM Checked:

KU

Project No.
5072
Drawing No.
A202
Revision:

WALL SURFACE FINISHES

BUILDING PERMIT

ISSUED 15/08/2021 NUMBER BS-L 40110-5804027263137

RELEVANT BUILDING SURVEYOR **Peter Lalor** BS-L 40110

TERMITE PROTECTION REQUIRED

RENDER FINISH SURFMIST COLOUR OR **SIMILAR**



HOUSE

Assessor Kajal Anand **Accreditation No.** DMN/18/1882

OQQ16JQQES 4 Aug 2021

Address

17 Dewhurst Circuit Cranbourne East VIC 3977



https://www.fr5.com.au/QRCodeLanding?PublicId=OQQ

FASCIA AND GUTTER MONUMENT

RF1 ROOF TILES WOODLAND GREY



FACE BRICK Chokalat Colour - Advance bricks and pavers



Surfmist®



4.8m WIDE GARAGE DOOR WOODLAND GREY SECTIONAL PANEL LEFT



RENDER FINISH MONUMENT COLOUR OR **SIMILAR**





FRONT DOOR WALNUT



DRIVEWAY COLOURED CONCRET CHARCOAL



- NO SLIIDNG WINDOWS TO THE FRONT FACADE
- NO INFILL OR RECESSED PANELS ABOVE
 DOORS, WINDOWS OR GARAGE DOORS
 FINISH ABOVE THE OPENING MUST MATCH THE
 FINISH ON EITHER SIDE OF THE OPENING
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- TWO OR MORE STOREYS DRIVEWAYS MUST TAPER TO THE WIDTH OF THE CROSSOVER AT THE BOUNDARY.



DRAWINGS. NOTE: PLANS ARE NOT TO BE SCALED.



	No.	Description	Date
HOME YOU DESERVE	A	CLIENT COPY	21-12-2020
HRAN HOMES	В	CLIENT COPY	02-01-2021
	С	CLIENT COPY	14-01-2021
	D	CLIENT COPY	30-03-2021
	E	DA APPROVAL	03-05-2021
	F	DA APPROVAL	03-06-2021
	G	BUILDING PERMIT	01-08-2021
	Н	BUILDING PERMIT	02-08-2021

PROJECT:

Single Storey House @ Lot 232_17 DEWHURST CIRCUIT, CRANBOURNE EAST

CLIENT:



Drawing Title:

FINISHES SCHEDULE



DEC 2020 Drawn: Author


Project No. 5072 Drawing No. A220


Revision:

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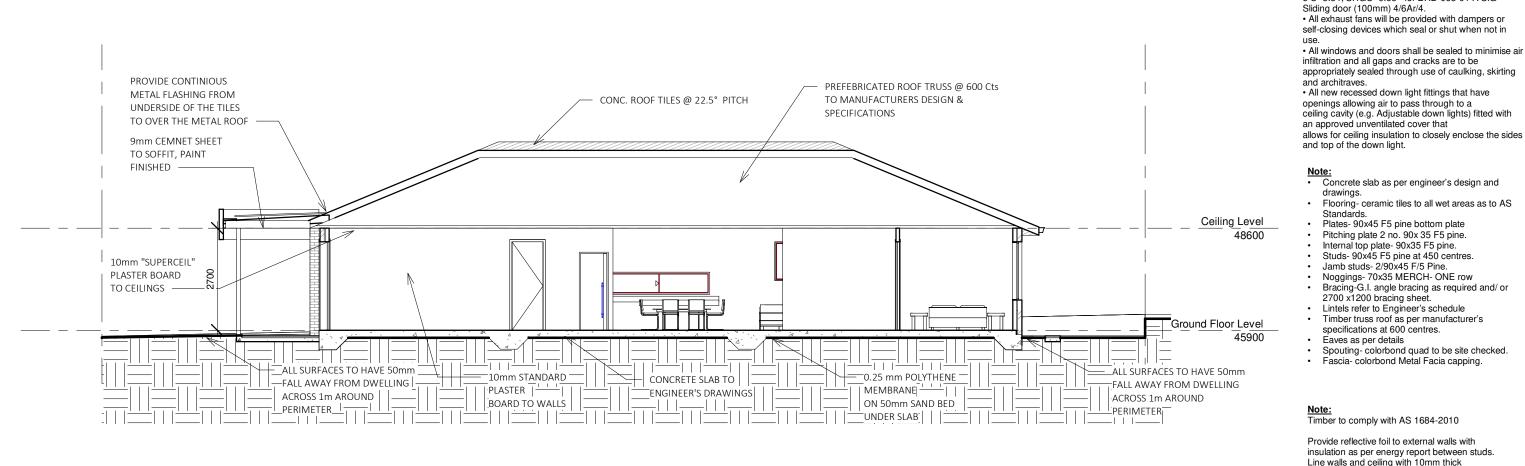
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FLASHING REQUIREMENTS FOR BATHS



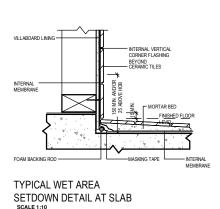

ERGON DESIGN STUDIO

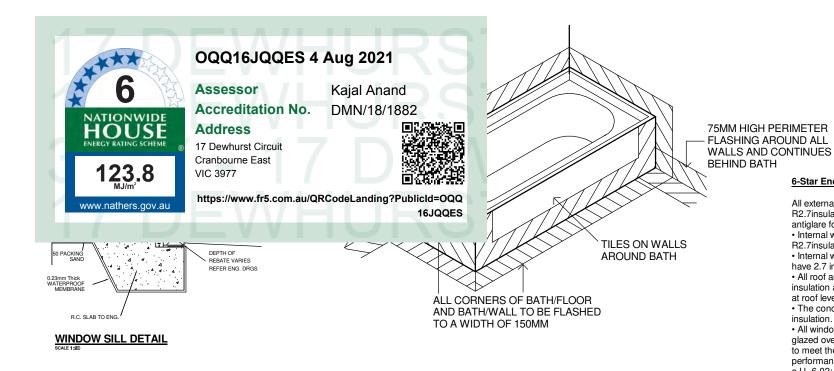IRAWINGS. IOTE: PLANS ARE NOT TO BE SCALED.



No.	Description	Date
A	CLIENT COPY	21-12-2020
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F	DA APPROVAL	03-06-2021
G	BUILDING PERMIT	01-08-2021
Н	BUILDING PERMIT	02-08-2021

PROJECT:

Single Storey House @ Lot 232_17 DEWHURST CIRCUIT, CRANBOURNE EAST

PRFI IMINARY

Drawing Title:

SECTION-1

NORTH

Note:

6-Star Energy Rating Requirements

R2.7insulation batts and one layer of antiglare foil (excluding garage).

insulation at the ceiling level and sarking

glazed over standard aluminium frames to meet the following total system thermal

Sliding Window Lite (52mm) 3Clr.

R2.7insulation batts.

performance values:

Lite (67mm) 4Clr.

drawings.

at roof level.

insulation.

have 2.7 insulation batts.

All external walls (brick veneer or similar) will have

· Internal walls of bathroom and laundry will have

Internal wall adjoining the garage and the house will

• All roof areas (excluding garage) will have R6.0 bulk

The concrete slab on ground for ground will have no

o U=6.02; SHGC=0.78- for BRD-063-01 A SIG Fixed

o U=6.85; SHGC=0.64– for BRD-081-16 A Signature

Awning Window 100 SG 4Clr.
o U=6.43; SHGC=0.76– for BRD-001-01 A ESS

• Sliding doors will be double glazed over standard aluminium frames to meet the following total system thermal performance values: o U=3.84: SHGC=0.65– for BRD-063-01 A SIG

Concrete slab as per engineer's design and

Standards.
Plates- 90x45 F5 pine bottom plate
Pitching plate 2 no. 90x 35 F5 pine.

Internal top plate- 90x35 F5 pine. Studs- 90x45 F5 pine at 450 centres.

Noggings- 70x35 MERCH- ONE row Bracing-G.I. angle bracing as required and/ or 2700 x1200 bracing sheet.
Lintels refer to Engineer's schedule

Timber truss roof as per manufacturer's

Spouting- colorbond quad to be site checked. Fascia- colorbond Metal Facia capping.

Jamb studs- 2/90x45 F/5 Pine.

specifications at 600 centres. Eaves as per details

plasterboard ready to be painted.

DEC 2020

KS

waterproofing as per AS 3740

Flooring- ceramic tiles to all wet areas as to AS

• All windows (excluding sliding doors) will be single

Project No. 5072 Drawing No.

Drawn A301 Checked: Revision:

Scale: As indicated @A3


CLIENT:

BUILDING PERMIT


ISSUED 15/08/2021 NUMBER BS-L 40110-5804027263137

RELEVANT BUILDING SURVEYOR **Peter Lalor** BS-L 40110

TERMITE PROTECTION REQUIRED

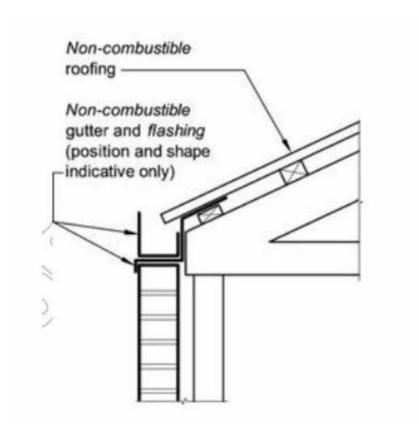



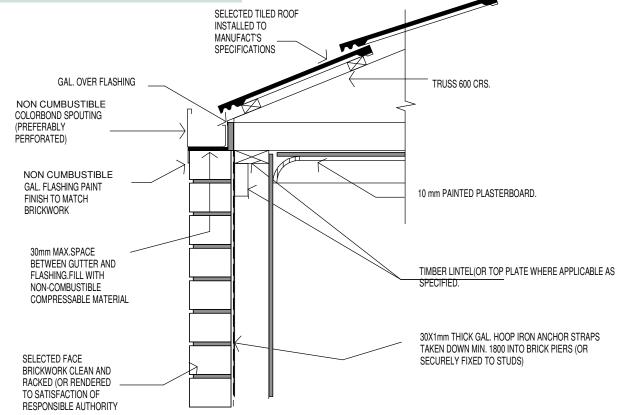

WALL ON BOUNDARY




DRAWINGS. NOTE: PLANS ARE NOT TO BE SCALED.



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E	DA APPROVAL	03-05-2021
F	DA APPROVAL	03-06-2021
G	BUILDING PERMIT	01-08-2021
Н	BUILDING PERMIT	02-08-2021

Single Storey House @ Lot 232_17 DEWHURST CIRCUIT, CRANBOURNE EAST

CLIENT:

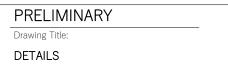




Date: DEC 2020 5072 Drawing No.

Scale: 1:10 @A3

A302 Author Checked: Revision: Checker

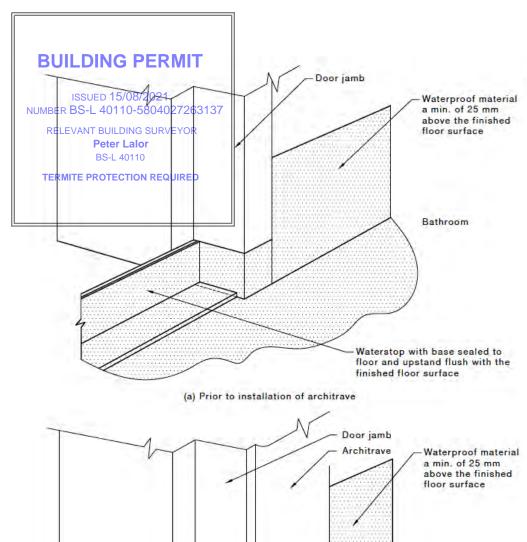

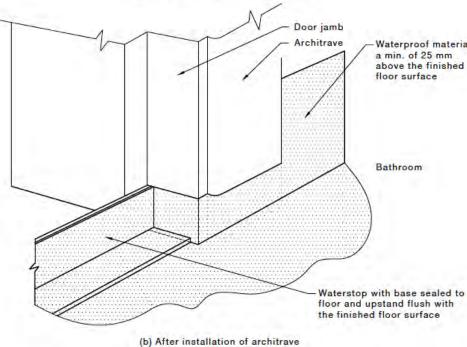
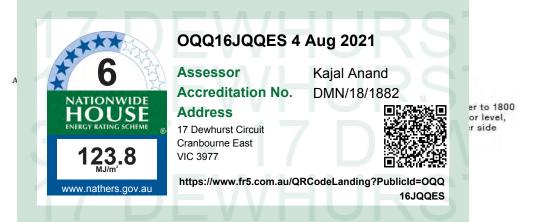


FIGURE 3.3 TYPICAL BATHROOM DOOR DETAIL FOR WHOLE BATHROOM WATERPROOFING




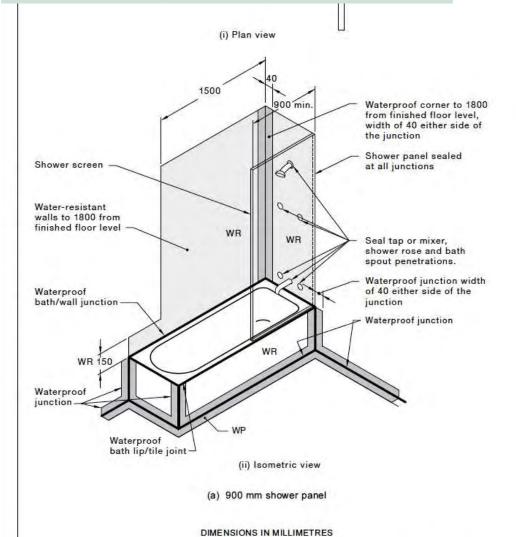


FIGURE C2 (in part) UNENCLOSED SHOWERS ABOVE BATHS—AREA PROTECTED FOR CONCRETE AND COMPRESSED FIBRE-CEMENT SHEET FLOORING



treen extrusions may not permit the water stop extending into a rebate. A channel o be installed over the water stop angle with the shower screen placed on top of the panels.

IGURE 3.6 TYPICAL HOBLESS CONSTRUCTION

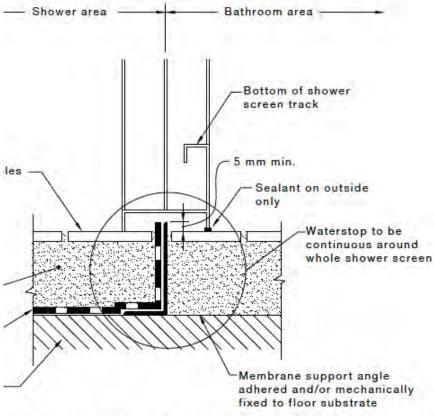

RAWINGS. IOTE: PLANS ARE NOT TO BE SCALED.



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PROJECT:


CLIENT:

Single Storey House @ Lot 232_17 DEWHURST CIRCUIT, CRANBOURNE EAST

DETAILS

Drawing Title

PRELIMINARY

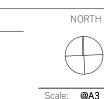


Date: DEC 2020 Drawn: Author

Checked

Checker

Project No. 5072 Drawing No. A303 Revision:

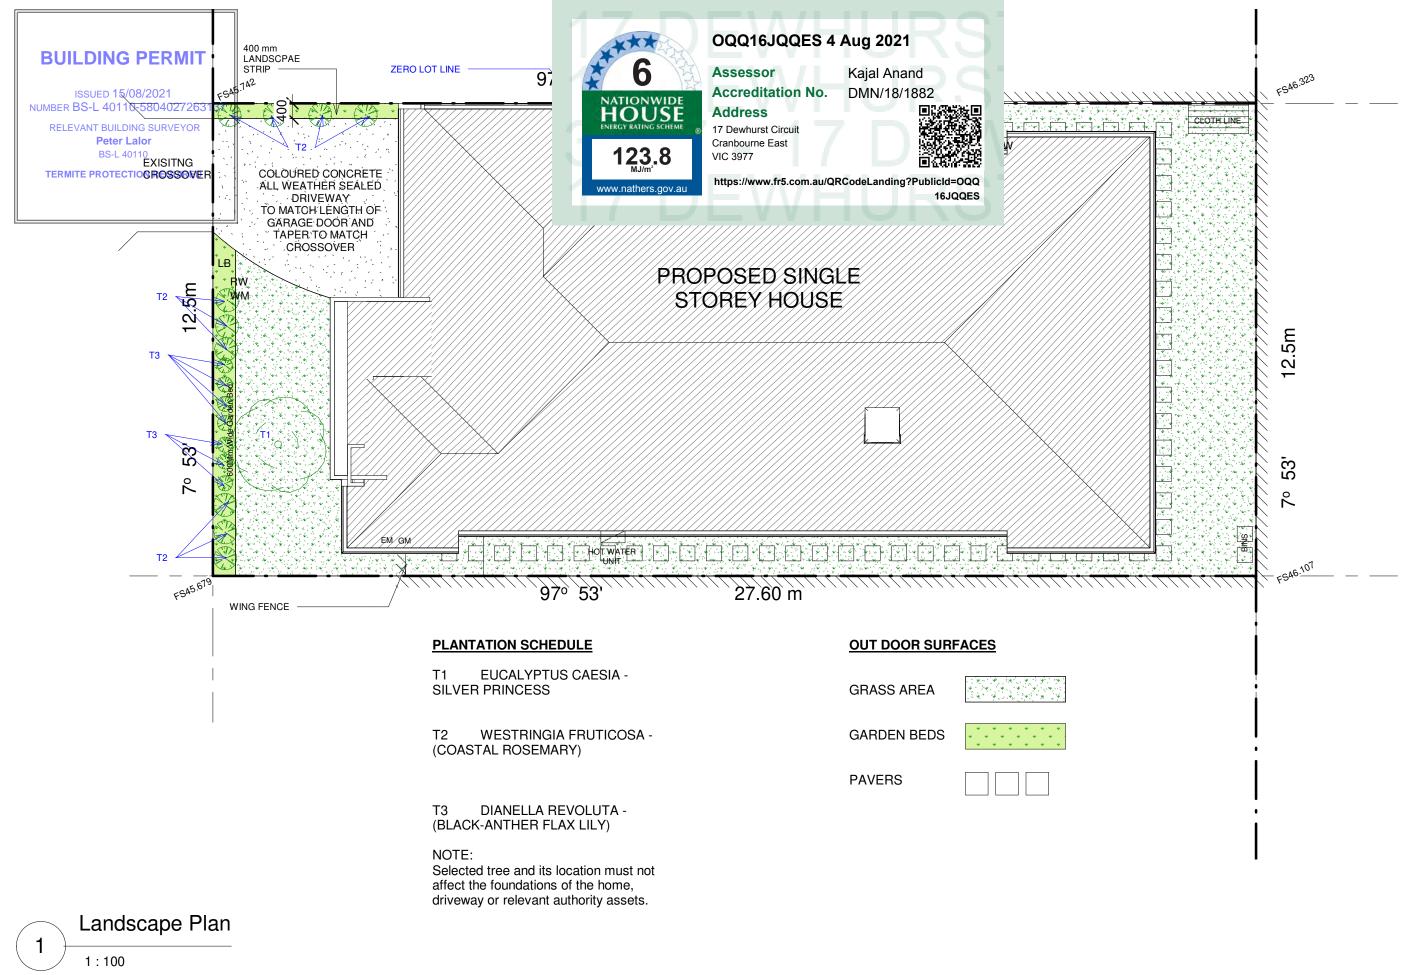





	No.	Description	Date
RAN HOMES	A	CLIENT COPY	21-12-2020
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	F	DA APPROVAL	03-06-2021
	G	BUILDING PERMIT	01-08-2021
	Н	BUILDING PERMIT	02-08-2021

Single Storey House @ Lot 232_17 DEWHURST Drawing Title: CIRCUIT, CRANBOURNE EAST

CLIENT:

LANDSCAPE PLAN



Date: DEC 2020 5072 Drawing No. A400 Author Checked: Revision:

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Scale: 1:100 @A3